



# BUILDING D - SWITCHGEAR PROJECT


GPO PURCHASE ORDER NUMBER: 3009811  
GOVERNMENT PRINTING OFFICE - BUILDING D  
735 N. CAPITOL ST, NW  
WASHINGTON DC 20401-0002

## PRE-PURCHASE DOCUMENTS AUGUST 01, 2011

RTKL PROJECT NUMBER: 00-11015.00



ARCHITECTURE/ PLANNING/ ENGINEERING  
RTKL ASSOCIATES, INC.  
901 S. BOND ST,  
BALTIMORE, MD 21231  
TEL 410 537 6000  
FAX 410 276 2136  
© 2011 RTKL ASSOCIATES INC.

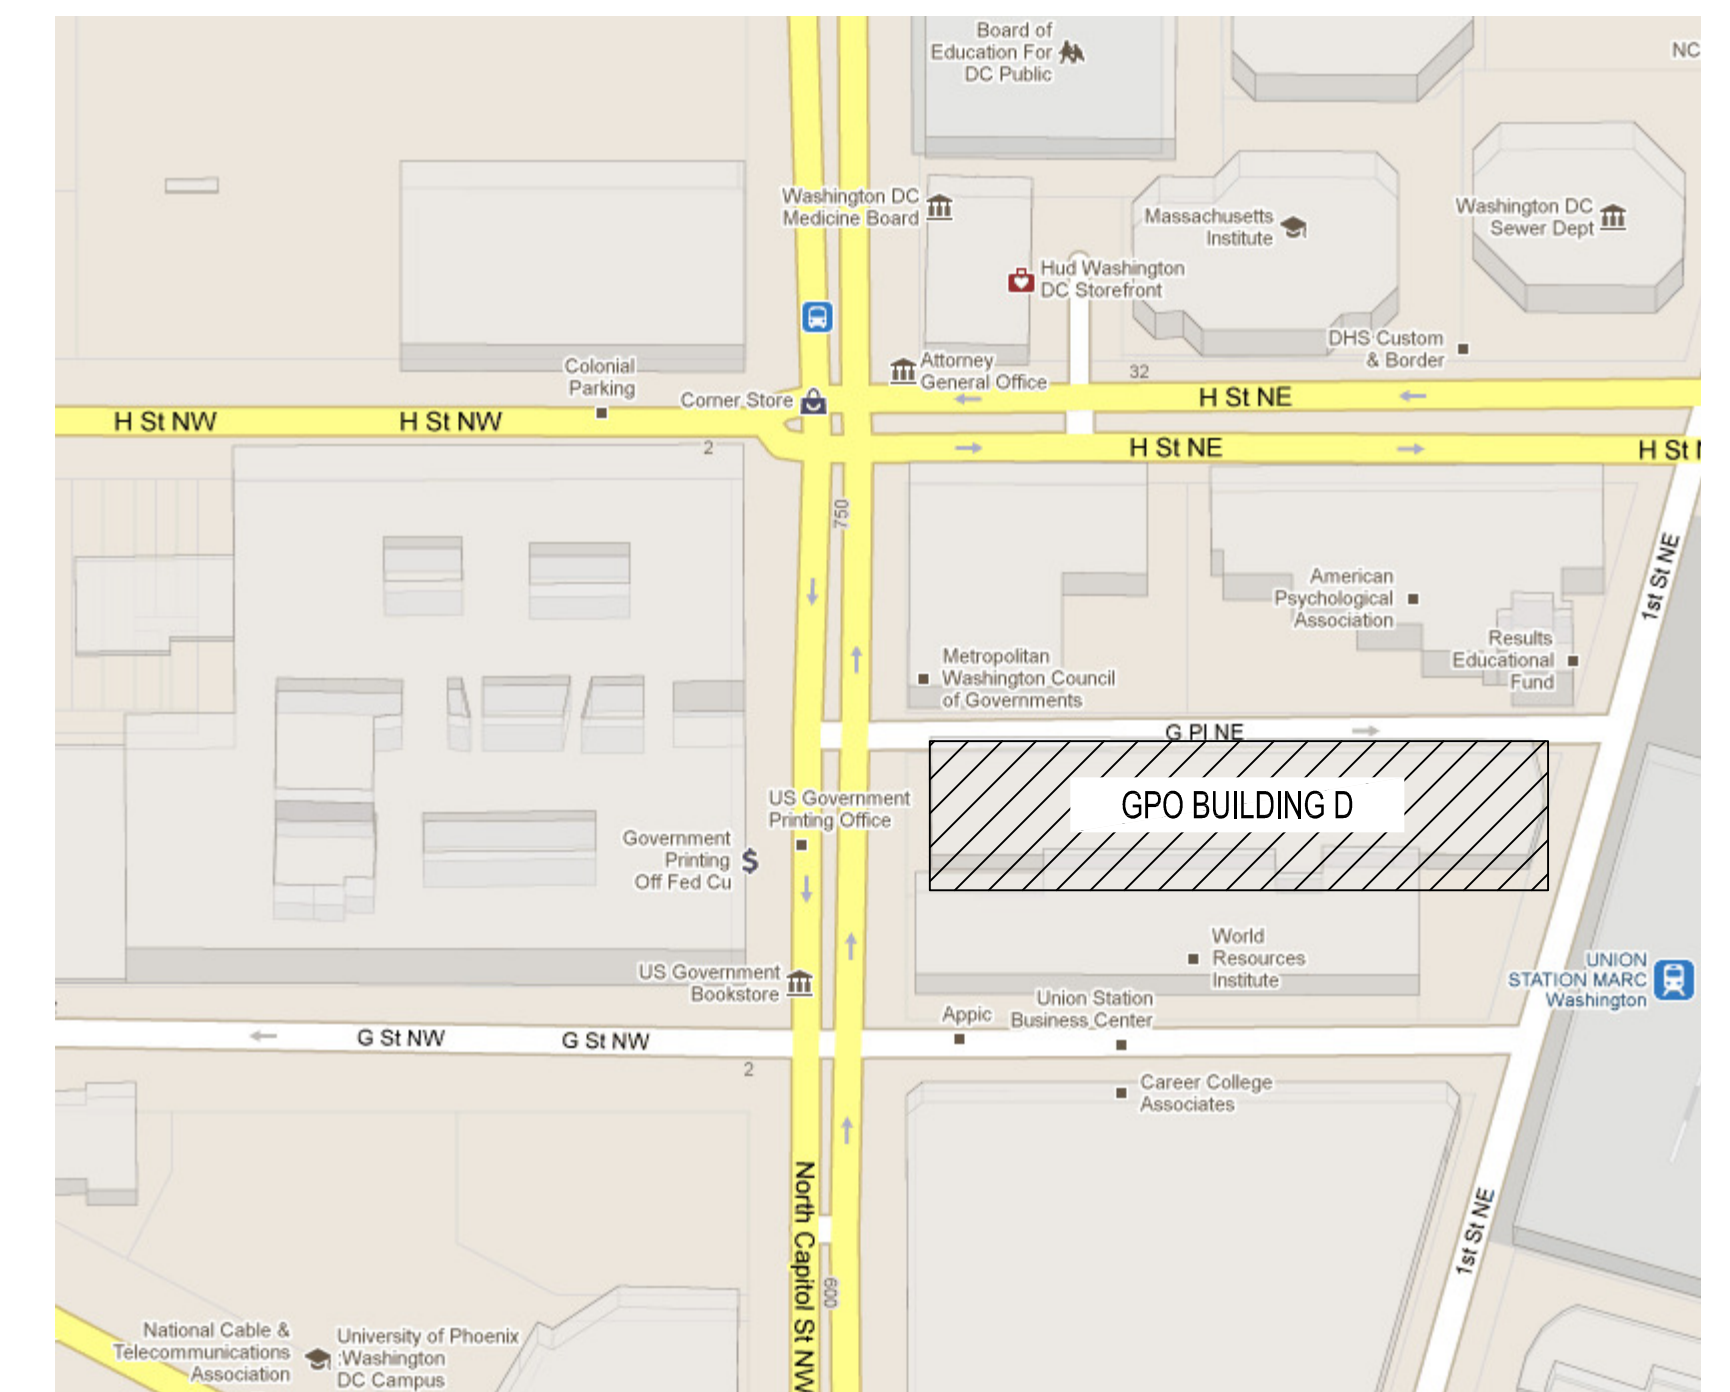

### DRAWING INDEX

GENERAL		ELECTRICAL	
G-000	COVER SHEET	E-001	LEGEND, SYMBOLS AND ABBREVIATIONS
		E-110	ELECTRICAL POWER PLAN - BASEMENT
		E-602	ELECTRICAL SINGLE LINE DIAGRAM

LIGHT FIXTURE SYMBOLS

Table with columns: SYMBOL, DESCRIPTIONS, and MOUNTING. Symbols include fluorescent strip fixtures (LP-1, LP-1.1), exit signs, and emergency lighting fixtures.

RECEPTACLE SYMBOLS

Table with columns: SYMBOL, DESCRIPTIONS, and AFF. UN. Symbols include standard receptacles (1-6" AFF, UN), duplex receptacles (4-6" AFF, UN), and telephone outlets.

ONE LINE DIAGRAM SYMBOLS

Table with columns: SYMBOL and DESCRIPTIONS. Symbols include digital multi-meters, surge suppressors, transient voltage surge suppressors, glow tubes, combination starters/disconnects, fuses, circuit breakers with trip and frame ampere rating, drawout circuit breakers, isolation transformers, wye grounded neutral windings, delta windings, motors, ammeters, voltmeters, watt meters, bus bars, key interlocks, electric interlocks, mechanical interlocks, contacts, normally closed contacts, thermal overloads, batteries, connections to ground, panelboards, utility company approved sockets, and programmable logic controllers.

POWER DISTRIBUTION CONTROL SYMBOLS

Table with columns: SYMBOL, DESCRIPTIONS, and MH (UON). Symbols include enclosed circuit breakers, non-fused disconnects, fused disconnects, combination starters/disconnects, pull boxes, transformers, hard wired connections, emergency power off devices, distribution boards, 120/208 volt panelboards, 277/480 volt panelboards, junction boxes for suspended ceilings, flush floor mounted, and wall mounted.

ABBREVIATIONS - ELECTRICAL

Comprehensive table of electrical abbreviations. Columns include the symbol and its corresponding description. Categories include amperes, conduit, drawings, emergency, fuses, ground, horsepower, junction boxes, kilovolts, linear foot, miscellaneous symbols (1P-3P), and receptacles.

PROJECT GENERAL NOTES:

- 1. THE INSTALLATION FOR ALL WORK SHALL BE IN ACCORDANCE WITH THE FOLLOWING REGULATIONS, CODES, ETC. A. LOCAL CODES AND ORDINANCES. B. THE LATEST EDITION OF NATIONAL ELECTRICAL CODE PRESENTLY IN EFFECT.
2. PRIOR TO BEGINNING ANY WORK, THE CONTRACTOR SHALL SECURE ANY NECESSARY PERMITS FROM THE AUTHORITY HAVING JURISDICTION...
3. ALL MATERIALS FURNISHED AND ALL WORK INSTALLED SHALL COMPLY WITH THE RULES AND RECOMMENDATIONS WHEN APPLICABLE OF THE LOCAL UTILITY COMPANY...
4. ALL EQUIPMENT SHALL BE "UL" LISTED AND BE SO LABELED, NO EXCEPTIONS.
5. BEFORE SUBMITTING BIDS, THE CONTRACTOR SHALL VISIT THE SITE AND EXAMINE ALL ADJOINING EXISTING EQUIPMENT...
6. THE CONTRACTOR SHALL COORDINATE WORK WITH ALL OTHER TRADES NEW OR EXISTING...
7. CONTRACTOR SHALL GUARANTEE WORK TO BE FREE FROM DEFECTS IN MATERIALS AND WORKMANSHIP...
8. GROUND SYSTEM IN ACCORDANCE WITH THE LATEST EDITION OF NATIONAL ELECTRIC CODE AND AS INDICATED ON DRAWINGS.
9. ALL ELECTRICAL CONDUCTORS, CONDUITS AND JUNCTION BOXES SHALL RUN BEHIND OR ABOVE FINISHED SURFACES...
10. ELECTRIC CONDUCTORS SHALL BE COPPER...
11. MINIMUM CONDUIT SIZE SHALL BE 3/4 INCH FOR POWER AND CONTROL CIRCUITS...
12. PROVIDE PULL WIRE IN ALL EMPTY CONDUITS.
13. THE CIRCUIT NUMBERS ARE FOR IDENTIFICATION PURPOSES...
14. ALL CONDUCTORS SHALL BE IDENTIFIED.
15. WHERE NEW WIRING AND DEVICES ARE TO BE INSTALLED IN EXISTING WALLS...
16. ALL POWER OUTAGES OR OTHER WORK AFFECTING EXISTING BUILDING OPERATIONS SHALL BE COORDINATED...
17. RUN ALL FIRE ALARM WIRING IN DEDICATED CONDUITS...
18. CONTROL AND POWER WIRING SHALL BE SEPARATED...
19. ALL PENETRATIONS THROUGH FIRE RATED CONSTRUCTION SHALL BE FIRESTOPPED...
20. PROVIDE DISCONNECT SWITCHES AND THERMAL MANUAL MOTOR STARTER SWITCHES...
21. LIGHTING FIXTURE LOCATIONS ARE DIAGRAMMATIC - EXACT LIGHTING FIXTURE LOCATIONS SHALL BE OBTAINED...
22. OUTLET LOCATIONS INDICATED ARE DIAGRAMMATIC AND SHOULD NOT BE SCALED...
23. CONTRACTOR SHALL SEAL ALL NEW CONDUIT PENETRATIONS THROUGH THE EXISTING WALLS...

MISCELLANEOUS SYMBOLS

Table with columns: SYMBOL and DESCRIPTIONS. Symbols include drawing note numbers, feeder numbers, drawing revision numbers, and feeder connection reference designations.

WIRING SYMBOLS

Table with columns: SYMBOL and DESCRIPTIONS. Symbols include flexible conduit connections, wires/conduits concealed above/below, wires/conduits to be removed, underground duct banks, stubbed out conduits, and homerun indications.

FIRE ALARM

Table with columns: SYMBOL and DESCRIPTIONS. Symbols include fire alarm manual pull stations, strobes, combination horn/strobes, smoke detectors, fire alarm control panels, and remote annunciator panels.

08/01/2011
ISSUED FOR
PRE-PURCHASE PACKAGE

NOT FOR CONSTRUCTION

UNITED STATES GOVERNMENT PRINTING OFFICE
WASHINGTON, D.C.
PURCHASE ORDER NUMBER: 3009811



RTKL
RYAN ASSOCIATES INC.
501 S. BOND ST.
BALTIMORE, MD 21201


PROJECT NO.: 00-1015.00

BUILDING D - SWITCHGEAR PROJECT

DRAWING SIZE: D (22" X 34")
DRAWING NO.:

E-001

DRAWING TITLE:
LEGEND, SYMBOLS AND
ABBREVIATIONS

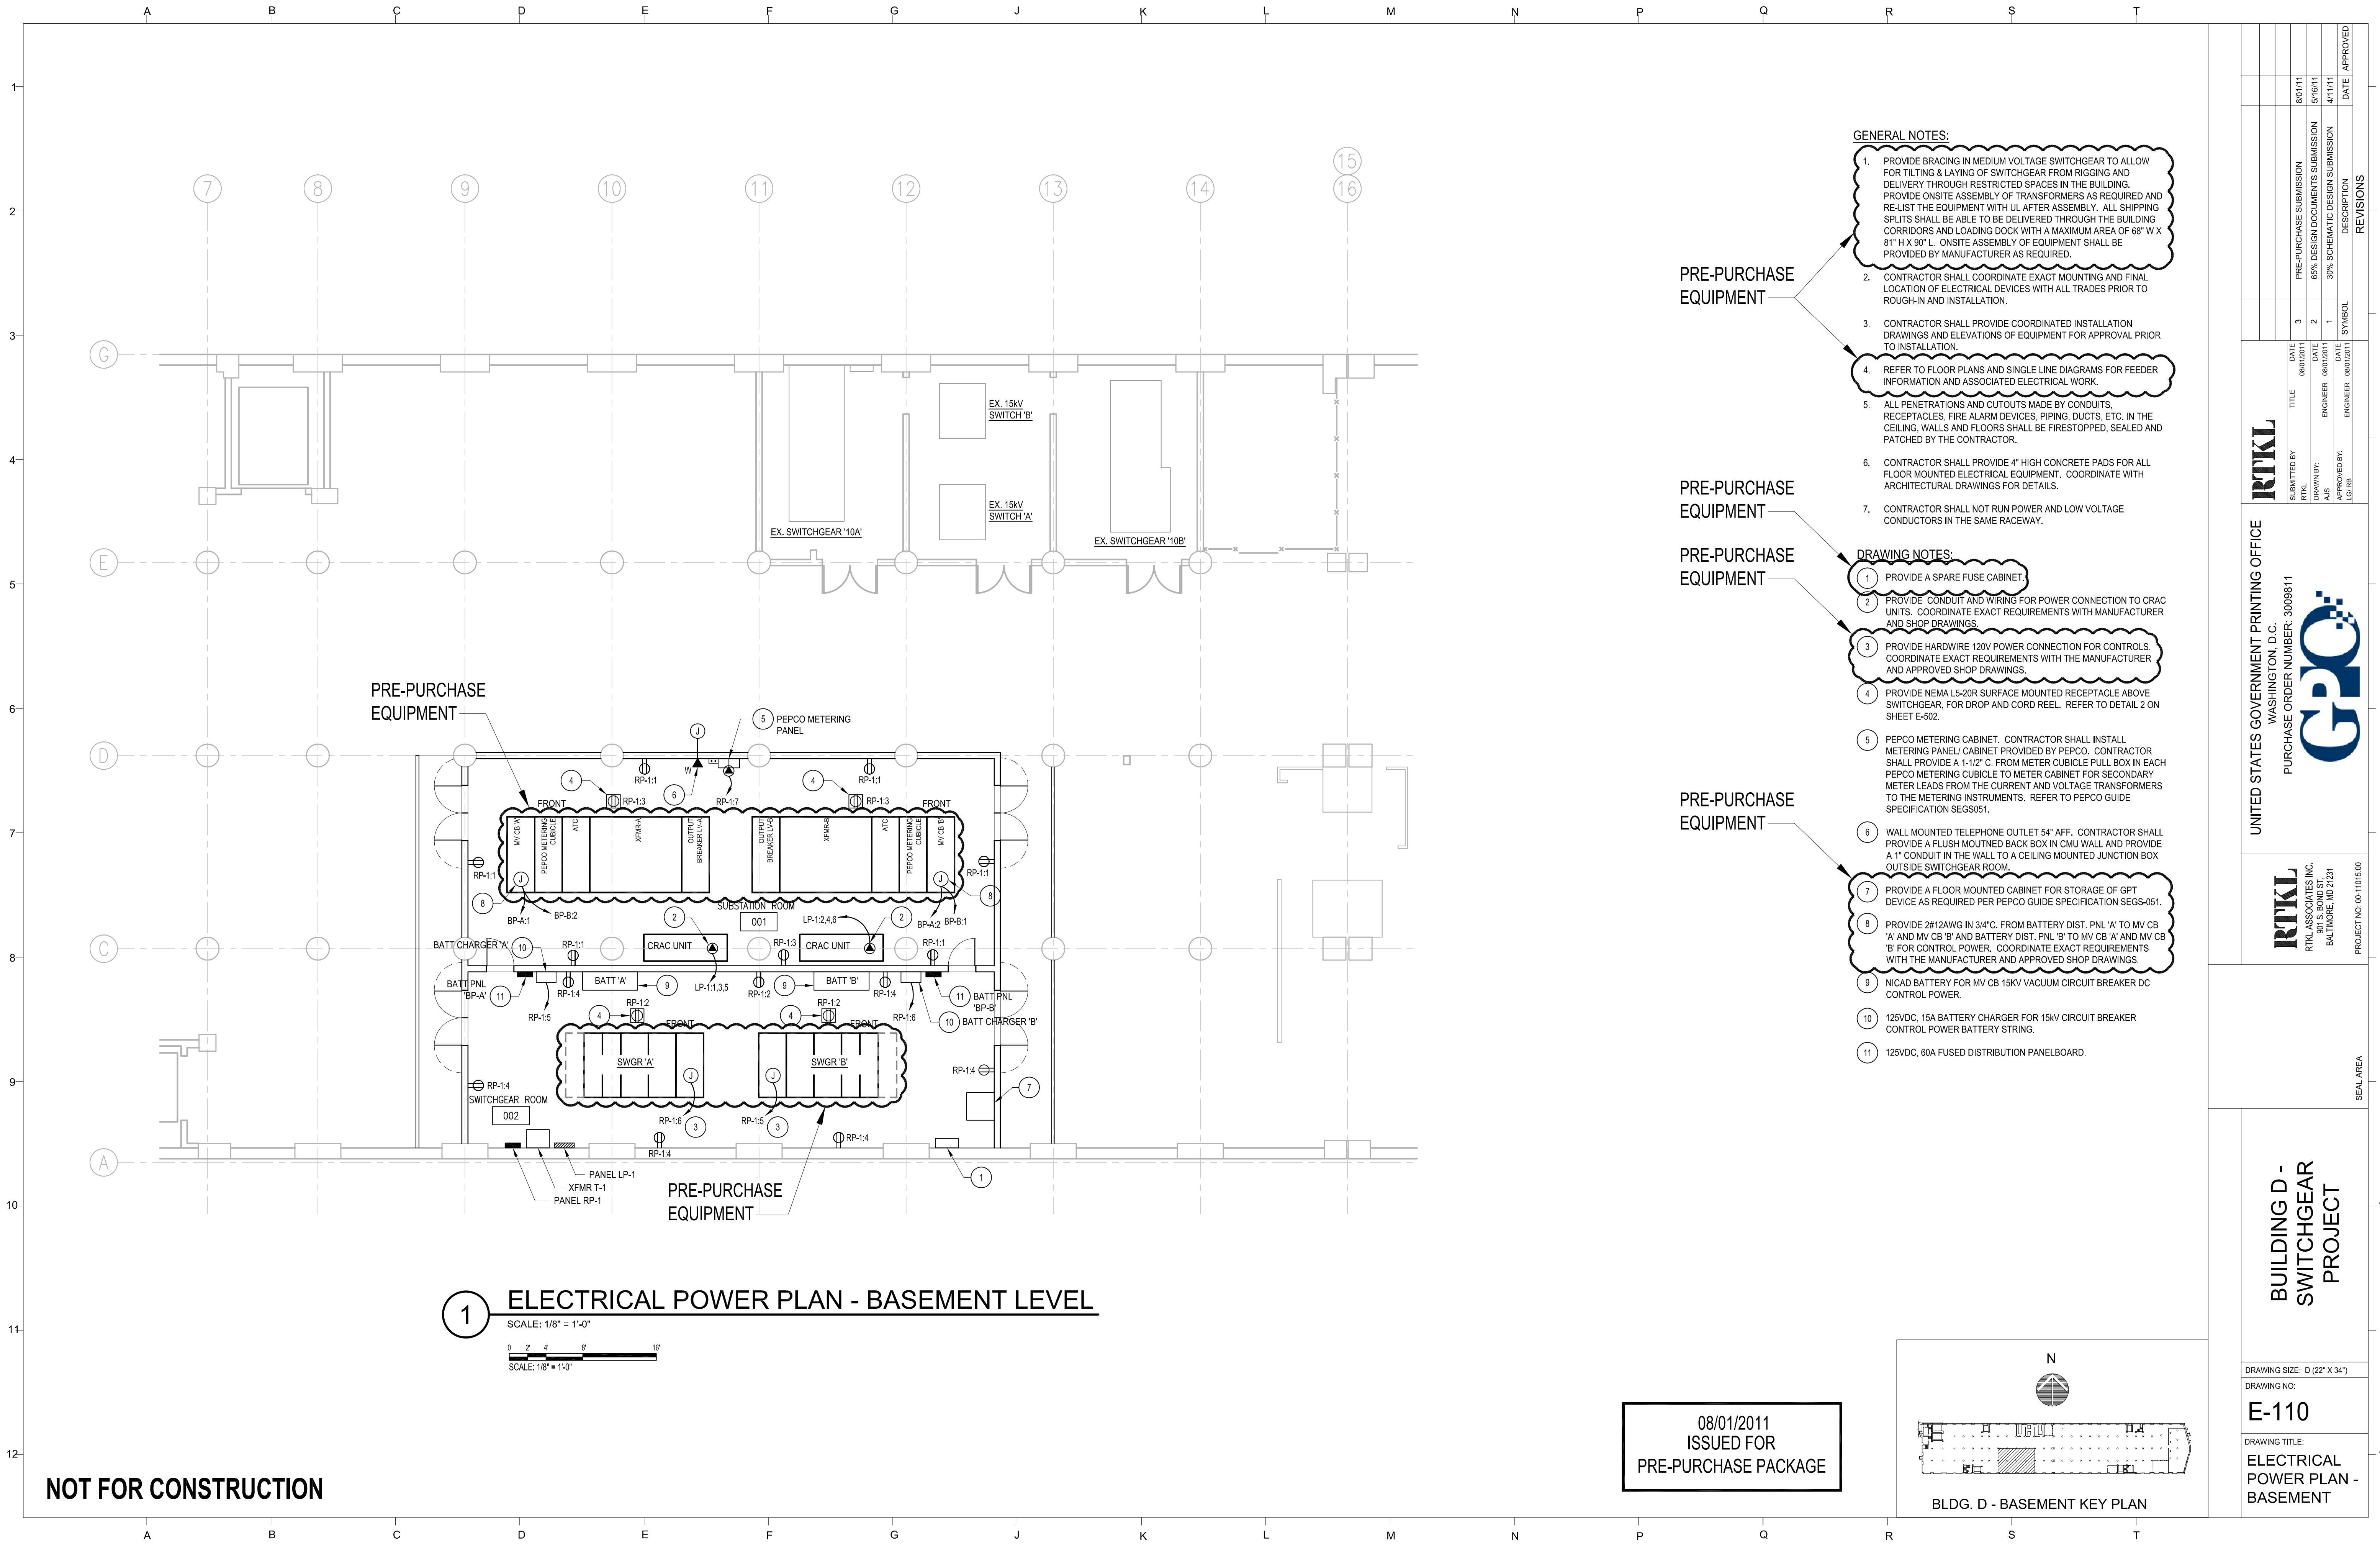

**GENERAL NOTES:**

1. PROVIDE BRACING IN MEDIUM VOLTAGE SWITCHGEAR TO ALLOW FOR TILTING & LAYING OF SWITCHGEAR FROM RIGGING AND DELIVERY THROUGH RESTRICTED SPACES IN THE BUILDING. PROVIDE ONSITE ASSEMBLY OF TRANSFORMERS AS REQUIRED AND RE-LIST THE EQUIPMENT WITH UL AFTER ASSEMBLY. ALL SHIPPING SPLITS SHALL BE ABLE TO BE DELIVERED THROUGH THE BUILDING CORRIDORS AND LOADING DOCK WITH A MAXIMUM AREA OF 68" W X 81" H X 90" L. ONSITE ASSEMBLY OF EQUIPMENT SHALL BE PROVIDED BY MANUFACTURER AS REQUIRED.
2. CONTRACTOR SHALL COORDINATE EXACT MOUNTING AND FINAL LOCATION OF ELECTRICAL DEVICES WITH ALL TRADES PRIOR TO ROUGH-IN AND INSTALLATION.
3. CONTRACTOR SHALL PROVIDE COORDINATED INSTALLATION DRAWINGS AND ELEVATIONS OF EQUIPMENT FOR APPROVAL PRIOR TO INSTALLATION.
4. REFER TO FLOOR PLANS AND SINGLE LINE DIAGRAMS FOR FEEDER INFORMATION AND ASSOCIATED ELECTRICAL WORK.
5. ALL PENETRATIONS AND CUTOUPS MADE BY CONDUITS, RECEPTACLES, FIRE ALARM DEVICES, PIPING, DUCTS, ETC. IN THE CEILING, WALLS AND FLOORS SHALL BE FIRESTOPPED, SEALED AND PATCHED BY THE CONTRACTOR.
6. CONTRACTOR SHALL PROVIDE 4" HIGH CONCRETE PADS FOR ALL FLOOR MOUNTED ELECTRICAL EQUIPMENT. COORDINATE WITH ARCHITECTURAL DRAWINGS FOR DETAILS.
7. CONTRACTOR SHALL NOT RUN POWER AND LOW VOLTAGE CONDUCTORS IN THE SAME RACEWAY.


**DRAWING NOTES:**

1. PROVIDE A SPARE FUSE CABINET.
2. PROVIDE CONDUIT AND WIRING FOR POWER CONNECTION TO CRAC UNITS. COORDINATE EXACT REQUIREMENTS WITH MANUFACTURER AND SHOP DRAWINGS.
3. PROVIDE HARDWIRE 120V POWER CONNECTION FOR CONTROLS. COORDINATE EXACT REQUIREMENTS WITH THE MANUFACTURER AND APPROVED SHOP DRAWINGS.
4. PROVIDE NEMA L5-20R SURFACE MOUNTED RECEPTACLE ABOVE SWITCHGEAR, FOR DROP AND CORD REEL. REFER TO DETAIL 2 ON SHEET E-502.
5. PEPCO METERING CABINET. CONTRACTOR SHALL INSTALL METERING PANEL/ CABINET PROVIDED BY PEPCO. CONTRACTOR SHALL PROVIDE A 1-1/2" C. FROM METER CUBICLE PULL BOX IN EACH PEPCO METERING CUBICLE TO METER CABINET FOR SECONDARY METER LEADS FROM THE CURRENT AND VOLTAGE TRANSFORMERS TO THE METERING INSTRUMENTS. REFER TO PEPCO GUIDE SPECIFICATION SEGS051.
6. WALL MOUNTED TELEPHONE OUTLET 54" AFF. CONTRACTOR SHALL PROVIDE A FLUSH MOUNTED BACK BOX IN CMU WALL AND PROVIDE A 1" CONDUIT IN THE WALL TO A CEILING MOUNTED JUNCTION BOX OUTSIDE SWITCHGEAR ROOM.
7. PROVIDE A FLOOR MOUNTED CABINET FOR STORAGE OF GPT DEVICE AS REQUIRED PER PEPCO GUIDE SPECIFICATION SEGS-051.
8. PROVIDE 2#12AWG IN 3/4" C. FROM BATTERY DIST. PNL 'A' TO MV CB 'A' AND MV CB 'B' AND BATTERY DIST. PNL 'B' TO MV CB 'A' AND MV CB 'B' FOR CONTROL POWER. COORDINATE EXACT REQUIREMENTS WITH THE MANUFACTURER AND APPROVED SHOP DRAWINGS.
9. NICAD BATTERY FOR MV CB 15KV VACUUM CIRCUIT BREAKER DC CONTROL POWER.
10. 125VDC, 15A BATTERY CHARGER FOR 15KV CIRCUIT BREAKER CONTROL POWER BATTERY STRING.
11. 125VDC, 60A FUSED DISTRIBUTION PANELBOARD.

**1 ELECTRICAL POWER PLAN - BASEMENT LEVEL**

SCALE: 1/8" = 1'-0"  
 0 2 4 8 16'  
 SCALE: 1/8" = 1'-0"

08/01/2011  
 ISSUED FOR  
 PRE-PURCHASE PACKAGE

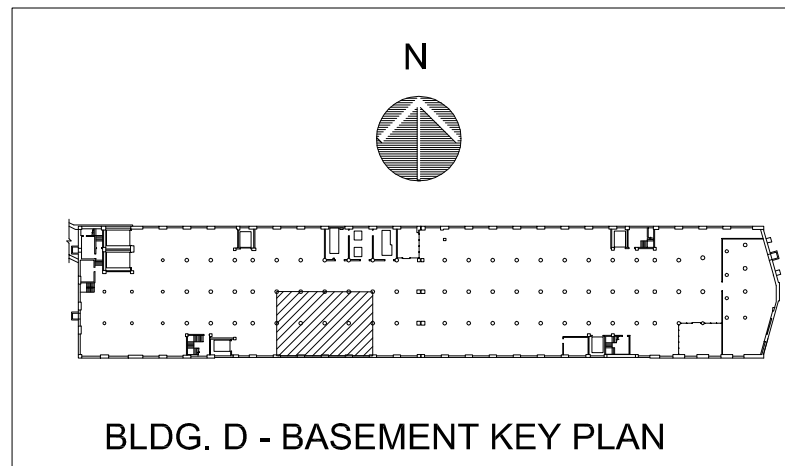

BLDG. D - BASEMENT KEY PLAN

**NOT FOR CONSTRUCTION**

UNITED STATES GOVERNMENT PRINTING OFFICE WASHINGTON, D.C. PURCHASE ORDER NUMBER: 3009811			
SUBMITTED BY: RTKL	DATE: 08/01/2011	TITLE: PRE-PURCHASE SUBMISSION	DATE: 08/01/11
DRAWN BY: ENGINEER	DATE: 08/01/2011	TITLE: 65% DESIGN DOCUMENTS SUBMISSION	DATE: 8/1/11
APPROVED BY: LG/RB	DATE: 08/01/2011	TITLE: 30% SCHEMATIC DESIGN SUBMISSION	DATE: 4/1/11
		SYMBOL: REVISIONS	DATE: APPROVED

**BUILDING D - SWITCHGEAR PROJECT**





DRAWING SIZE: D (22" X 34")  
 DRAWING NO:  
**E-110**  
 DRAWING TITLE:  
**ELECTRICAL POWER PLAN - BASEMENT**

**GENERAL NOTES:**

- REFER TO GROUNDING RISER FOR SERVICE ENTRANCE SWITCHGEAR AND TRANSFORMER GROUNDING.
- MEDIUM VOLTAGE CABLES SHALL BE COPPER CONDUCTOR WITH MV-105, 133% EPR INSULATION.
- REFER TO FLOOR PLANS FOR ACTUAL LOCATION OF EQUIPMENT.
- SEE SITE PLAN AND DETAILS FOR PEPCO DUCT BANK ROUTING CONSTRUCTION DETAILS.
- ANY CONTROL, COMMUNICATIONS, MONITORING, ETC. WIRING SHALL BE RUN IN DEDICATED RACEWAYS, INDEPENDENT OF POWER WIRING.
- ALL CONDUITS SHALL BE SUPPORTED FROM CEILING, UNLESS NOTED OTHERWISE.
- DMM INDICATES SQUARE D CM4000T, SIEMENS 9610, GE EPM 9650 POWER QUALITY METER OR APPROVED EQUAL.
- REFER TO CIVIL DRAWINGS FOR EXACT LOCATION AND DETAILS OF ELECTRICAL DUCTBANK.

**DRAWING NOTES:**

- FOUR-WAY DUCT BANK WITH 5" FIBERGLASS REINFORCED EPOXY (FRE) CONDUIT PROVIDED BY THE UTILITY COMPANY FROM THE UTILITY MANHOLE TO BUILDING ENTRANCE. SERVICE FEEDERS FROM MANHOLE TO MV-CB, CONDUCTOR TERMINATION AND BUS INSULATION FOR THE SERVICE FEEDERS SHALL BE PROVIDED BY THE UTILITY COMPANY AS INDICATED IN PEPCO SPECIFICATION GUIDE SEGS-051.
- N-G BOND SHALL BE ESTABLISHED AT LOW VOLTAGE SWITCHGEAR 'SWGR-A' AS INDICATED.
- SURGE SUPPRESSORS SHALL BE LOCATED IN A SEPARATE BARRIER WITHIN THE SWITCHGEAR. RUN 1/2 AWG DISCHARGE GROUND TO SWITCHGEAR GROUND BUS.
- PROVIDE PROVISIONS FOR FUTURE BUSWAY CONNECTIONS.
- PROVIDE ONE (1) 4000AF CIRCUIT BREAKER CRATED AND SHIPPED LOOSE WITH THE SWITCHGEAR.
- PROVIDE POWER MONITORING CABLE FROM EACH CIRCUIT BREAKER TRIP UNIT WITHIN THE SWITCHGEAR TO EGX-100 OR APPROVED EQUAL ETHERNET GATEWAY LOCATED WITHIN THE SWITCHGEAR. PROVIDE POWER MONITORING CABLE FROM EACH DIGITAL MULTI METER WITHIN THE SWITCHGEAR TO ELECTRICAL POWER MONITORING SWITCH. COORDINATE EXACT REQUIREMENTS WITH THE POWER MONITORING RISER DIAGRAM AND SHOP DRAWINGS.
- C.T., P.T. AND CURRENT LIMITING FUSES FOR UTILITY METERING SHALL BE PROVIDED BY PEPCO AND SHALL BE INSTALLED BY THE CONTRACTOR WITHIN THE SUBSTATION LINEUP. CONTRACTOR SHALL PROVIDE INSTALLATION AND GROUNDING AS REQUIRED PER PEPCO SPECIFICATION GUIDE SEGS-051.
- CONTRACTOR SHALL PROVIDE A JUNCTION BOX TO INTERCEPT EXISTING FEEDERS AS INDICATED. REFER TO FLOOR PLANS FOR DETAILS.
- PROVIDE CONDUIT/ CONDUCTOR SIMILAR IN SIZE AND TYPE TO EXISTING. CONDUCTOR SHALL BE SPLICED TO EXISTING CONDUCTOR IN THE JUNCTION BOX.
- PROVIDE CLASS 'A3' TVSS NEXT TO PANELBOARD. REFER TO INSTALLATION DETAIL #2 ON DRAWING E-505.
- REFER TO INSTALLATION DETAIL #2 ON DRAWING E-505.
- UTILITY SERVICE FEEDER ON CABLE TRAY. REFER TO ELECTRICAL FLOOR PLAN FOR CABLE TRAY ROUTING INFORMATION. SERVICE FEEDERS FROM MANHOLE TO MV-CB, CONDUCTOR TERMINATION AND BUS INSULATION FOR THE SERVICE FEEDERS SHALL BE PROVIDED BY THE UTILITY COMPANY AS INDICATED IN PEPCO SPECIFICATION GUIDE SEGS-051.
- PROVIDE GLOW TUBES, TYPE R OR RS ON THE LINE SIDE OF EACH PHASE OF THE INCOMING FEEDER. MANUFACTURER SHALL PROVIDE VIEWING GLASS ON THE CUBICLE DOOR. COORDINATE EXACT REQUIREMENTS WITH PEPCO GUIDE SPECIFICATION SEGS051.
- PROVIDE THREE SINGLE POLE ARRESTERS RATED FOR 15KV, 30, 3W SERVICE AS REQUIRED PER PEPCO GUIDE SPECIFICATION SEGS051.
- CONTRACTOR SHALL PROVIDE ONE (1) 1-1/2" RIGID METAL CONDUIT FROM PULL-BOX IN PEPCO METERING CUBICLE TO REMOTE MOUNTED PEPCO METERING CABINET INSTALLED ON SWITCHGEAR ROOM WALL, AS REQUIRED PER PEPCO GUIDE SPECIFICATION SEGS051.
- CONTRACTOR SHALL PROVIDED CONNECTION BETWEEN CONTRACTOR PROVIDED SLEEVES IN GPO BUILDING D WALL AND CONDUITS IN THE DUCT BANK PROVIDED BY THE UTILITY COMPANY. COORDINATE REQUIREMENTS WITH THE UTILITY COMPANY ARCHITECTURAL AND STRUCTURAL DRAWINGS.
- SEL-751A MULTI-FUNCTION RELAY. REFER TO DETAIL 2 ON THIS SHEET FOR ADDITIONAL INFORMATION.

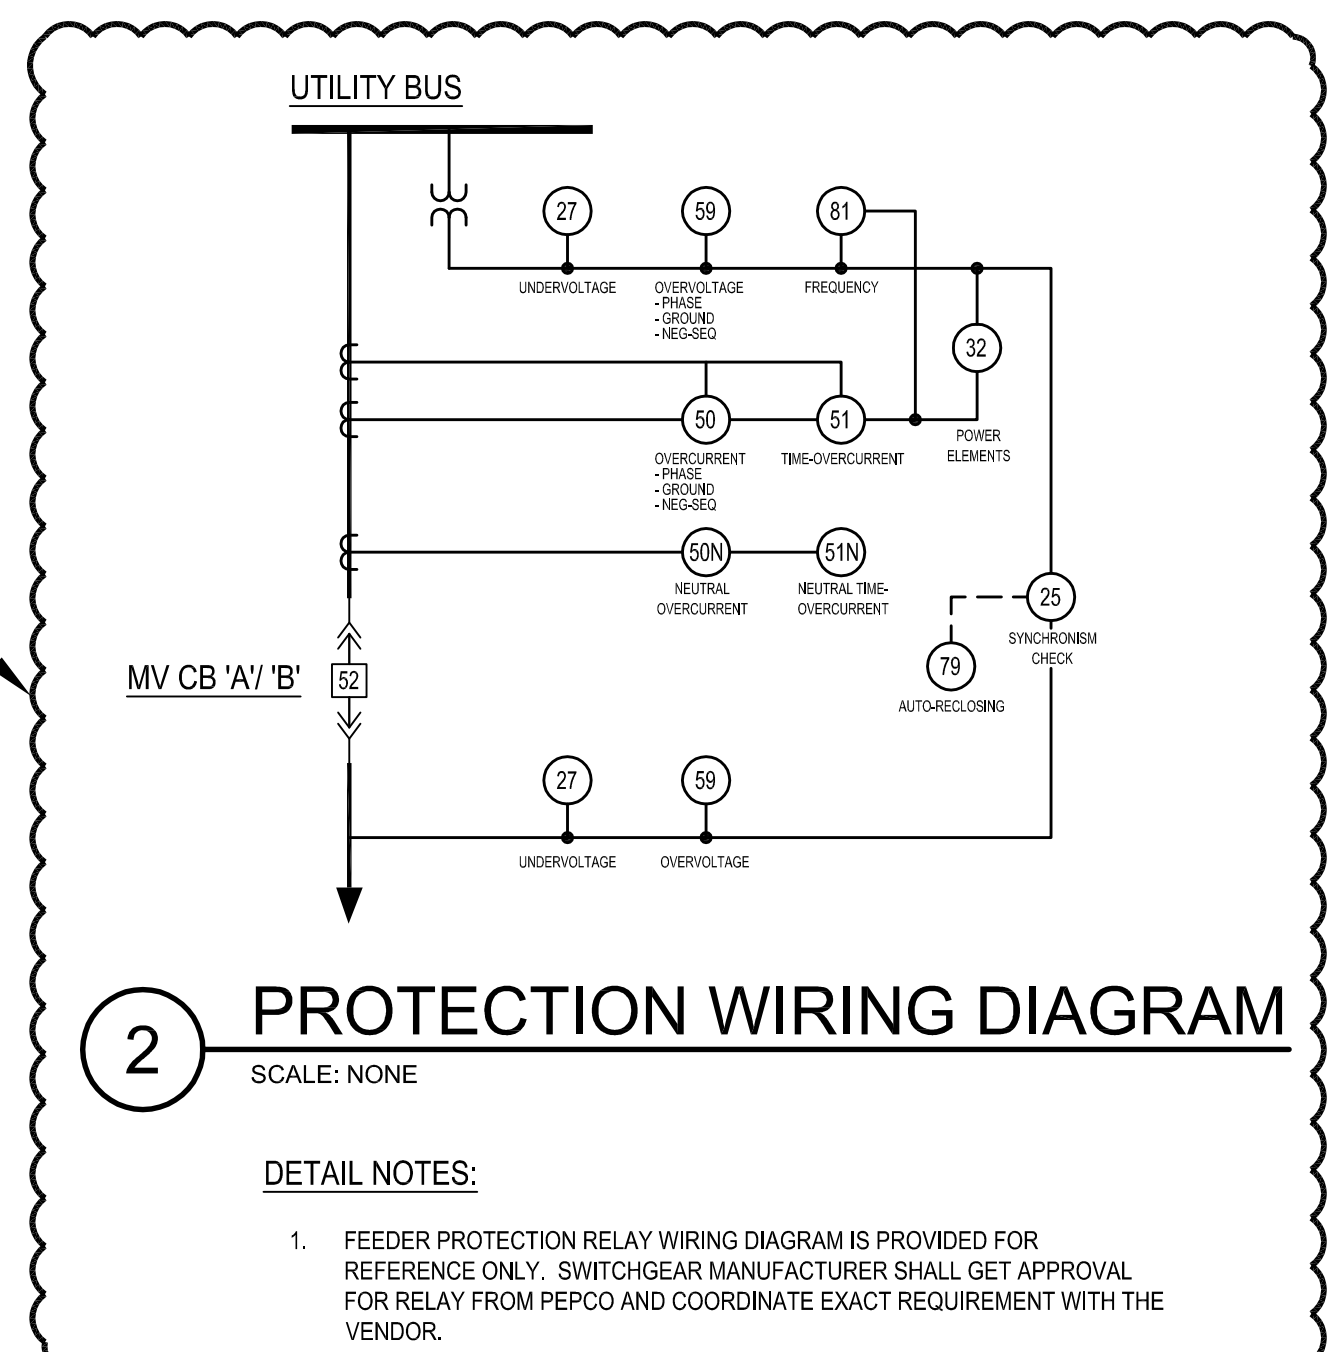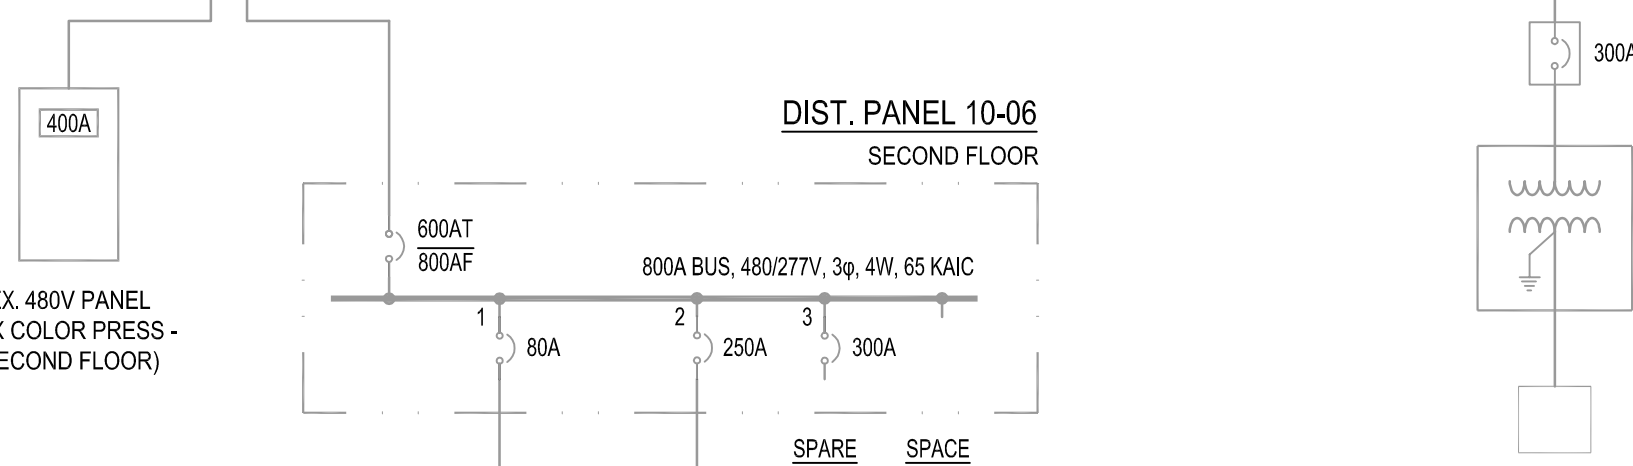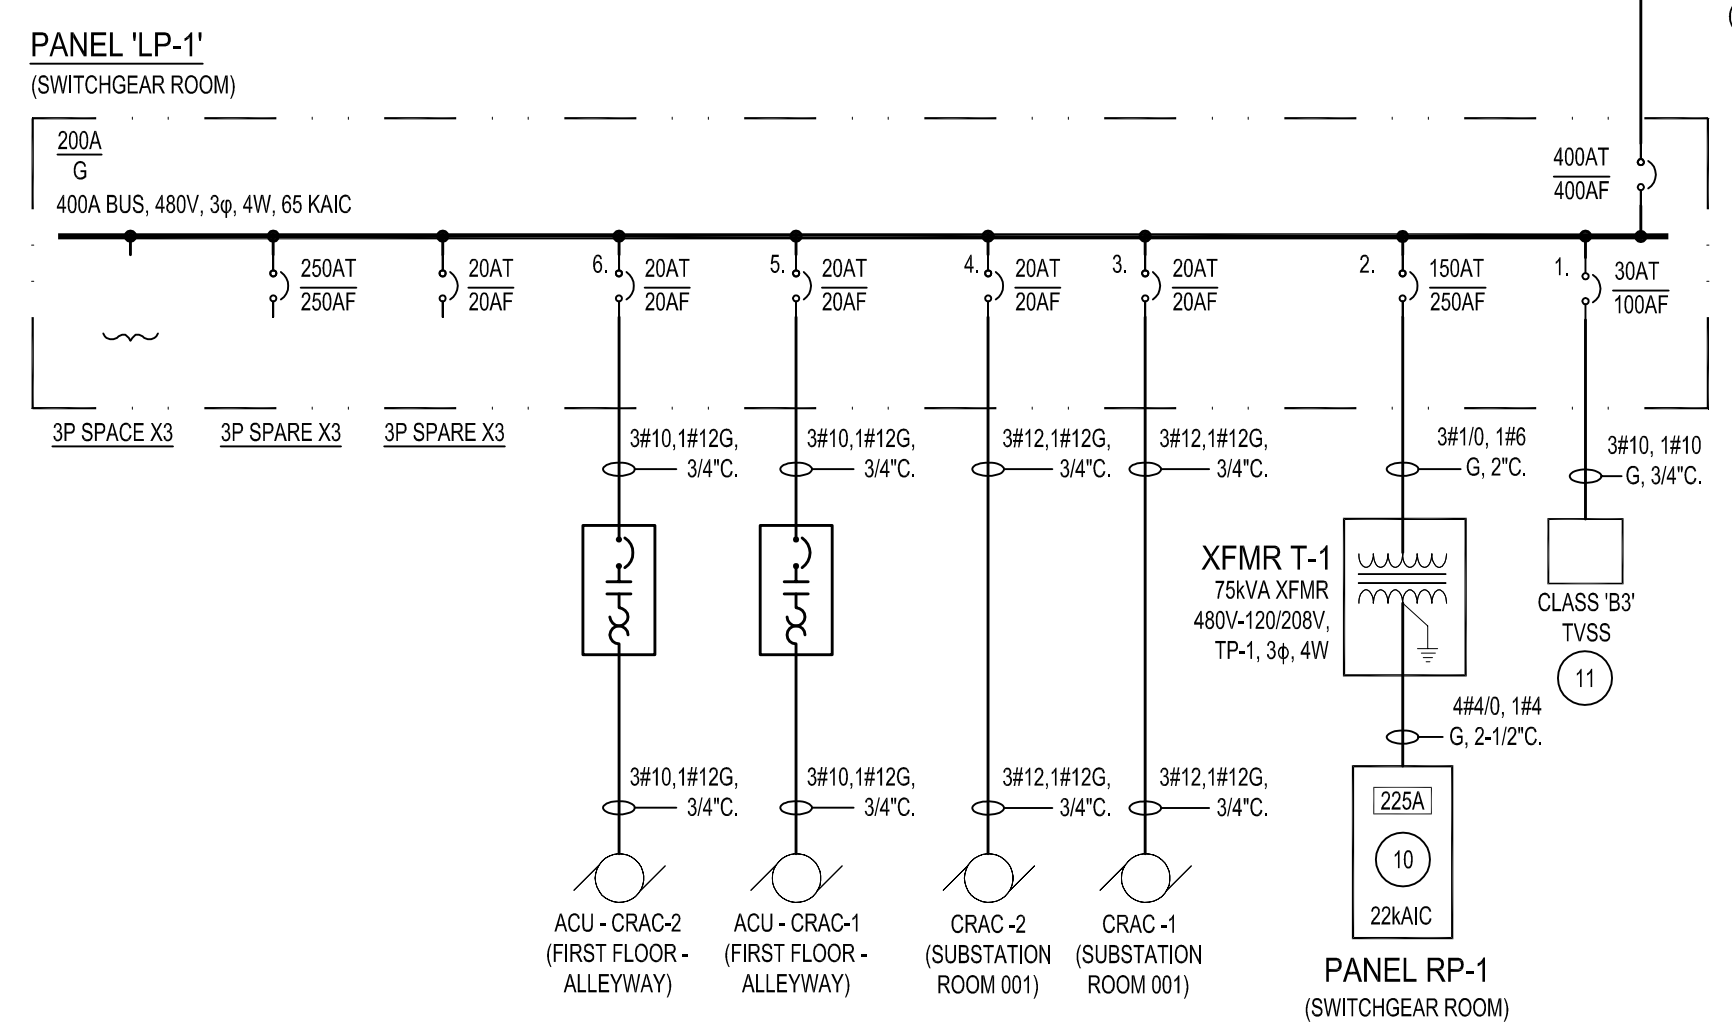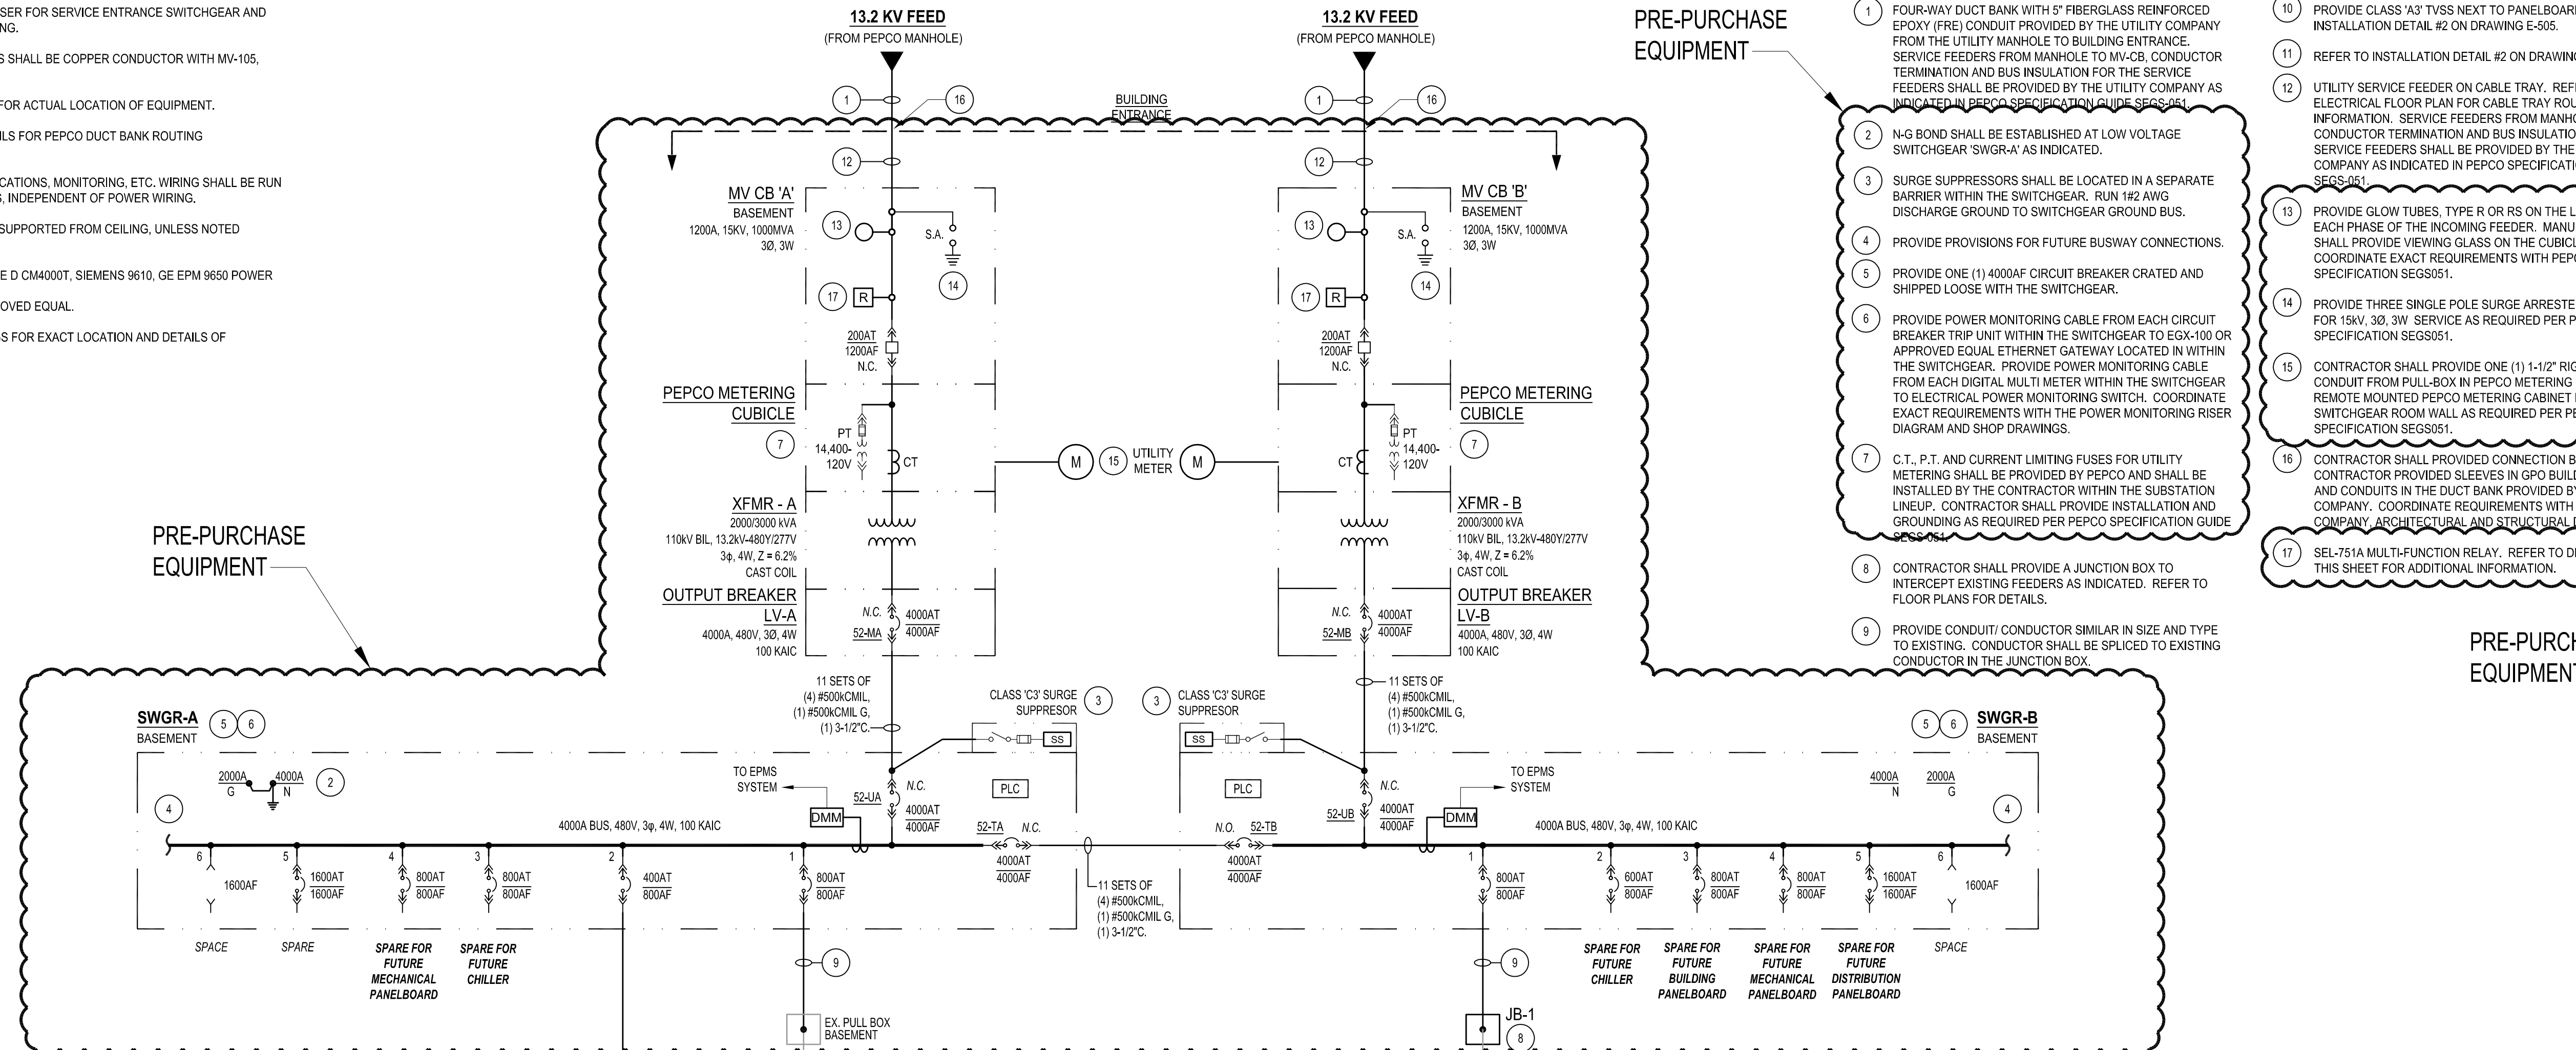

**1 ELECTRICAL SINGLE LINE DIAGRAM**  
SCALE: NONE

**2 PROTECTION WIRING DIAGRAM**  
SCALE: NONE

- DETAIL NOTES:**
- FEEDER PROTECTION RELAY WIRING DIAGRAM IS PROVIDED FOR REFERENCE ONLY. SWITCHGEAR MANUFACTURER SHALL GET APPROVAL FOR RELAY FROM PEPCO AND COORDINATE EXACT REQUIREMENT WITH THE VENDOR.

08/01/2011  
ISSUED FOR  
PRE-PURCHASE PACKAGE

**NOT FOR CONSTRUCTION**

RTKL		SUBMITTED BY		DATE	08/01/2011
RTKL		DRAWN BY		DATE	08/01/2011
RTKL		APPROVED BY		DATE	08/01/2011
RTKL		CHECKED BY		DATE	08/01/2011

NO.	DATE	DESCRIPTION	BY	APPROVED
1	08/01/2011	PRE-PURCHASE SUBMISSION	ALS	
2	08/01/2011	65% DESIGN DOCUMENTS SUBMISSION	ALS	
3	08/01/2011	30% SCHEMATIC DESIGN SUBMISSION	ALS	

UNITED STATES GOVERNMENT PRINTING OFFICE WASHINGTON, D.C. PURCHASE ORDER NUMBER: 3009811	RTKL ASSOCIATES, INC. BALTIMORE, MD 21231 PROJECT NO. 09-11015.00
--	---

<b>BUILDING D - SWITCHGEAR PROJECT</b>
DRAWING SIZE: D (22" X 34")
DRAWING NO: <b>E-602</b>
DRAWING TITLE: <b>ELECTRICAL SINGLE LINE DIAGRAM</b>